






DRAINAGE DATA		
DESIGN POINT	Q5 (CFS)	Q100 (CFS)
DP1	24.4	45.8
DP2	24.8	47.2
DP3	47.6	89.7
DP4	25.8	49.3
DP5	67.4	127.6
DP6	13.2	24.0
DP7	38.4	73.7
DP8	39.3	76.7
DP9	91.8	176.2
DP10	100.1	193.2
DP11	34.4	67.4
DP12	62.4	116.2
DP13	96.1	182.3
DP14	123.7	237.6
DP15	150.3	291.1
DP16	147.6	286.4
DP17	226.1	437.7
DP18	8.9	17.8
DP19	45.6	91.0
DP20	48.0	95.8
DP21	23.7	48.3
DP22	50.3	101.8
DP23	96.5	194.1
DP24	312.6	611.7

INLET TABLE		
I-1	30" D10R	EXISTING
I-2	20" D10R	EXISTING
I-3	20" D10R	EXISTING

HDPE PIPE TABLE		
DESIGNATION	SIZE	STATUS
P-1	36"	EXISTING
P-2	30"	EXISTING
P-3	30"	EXISTING

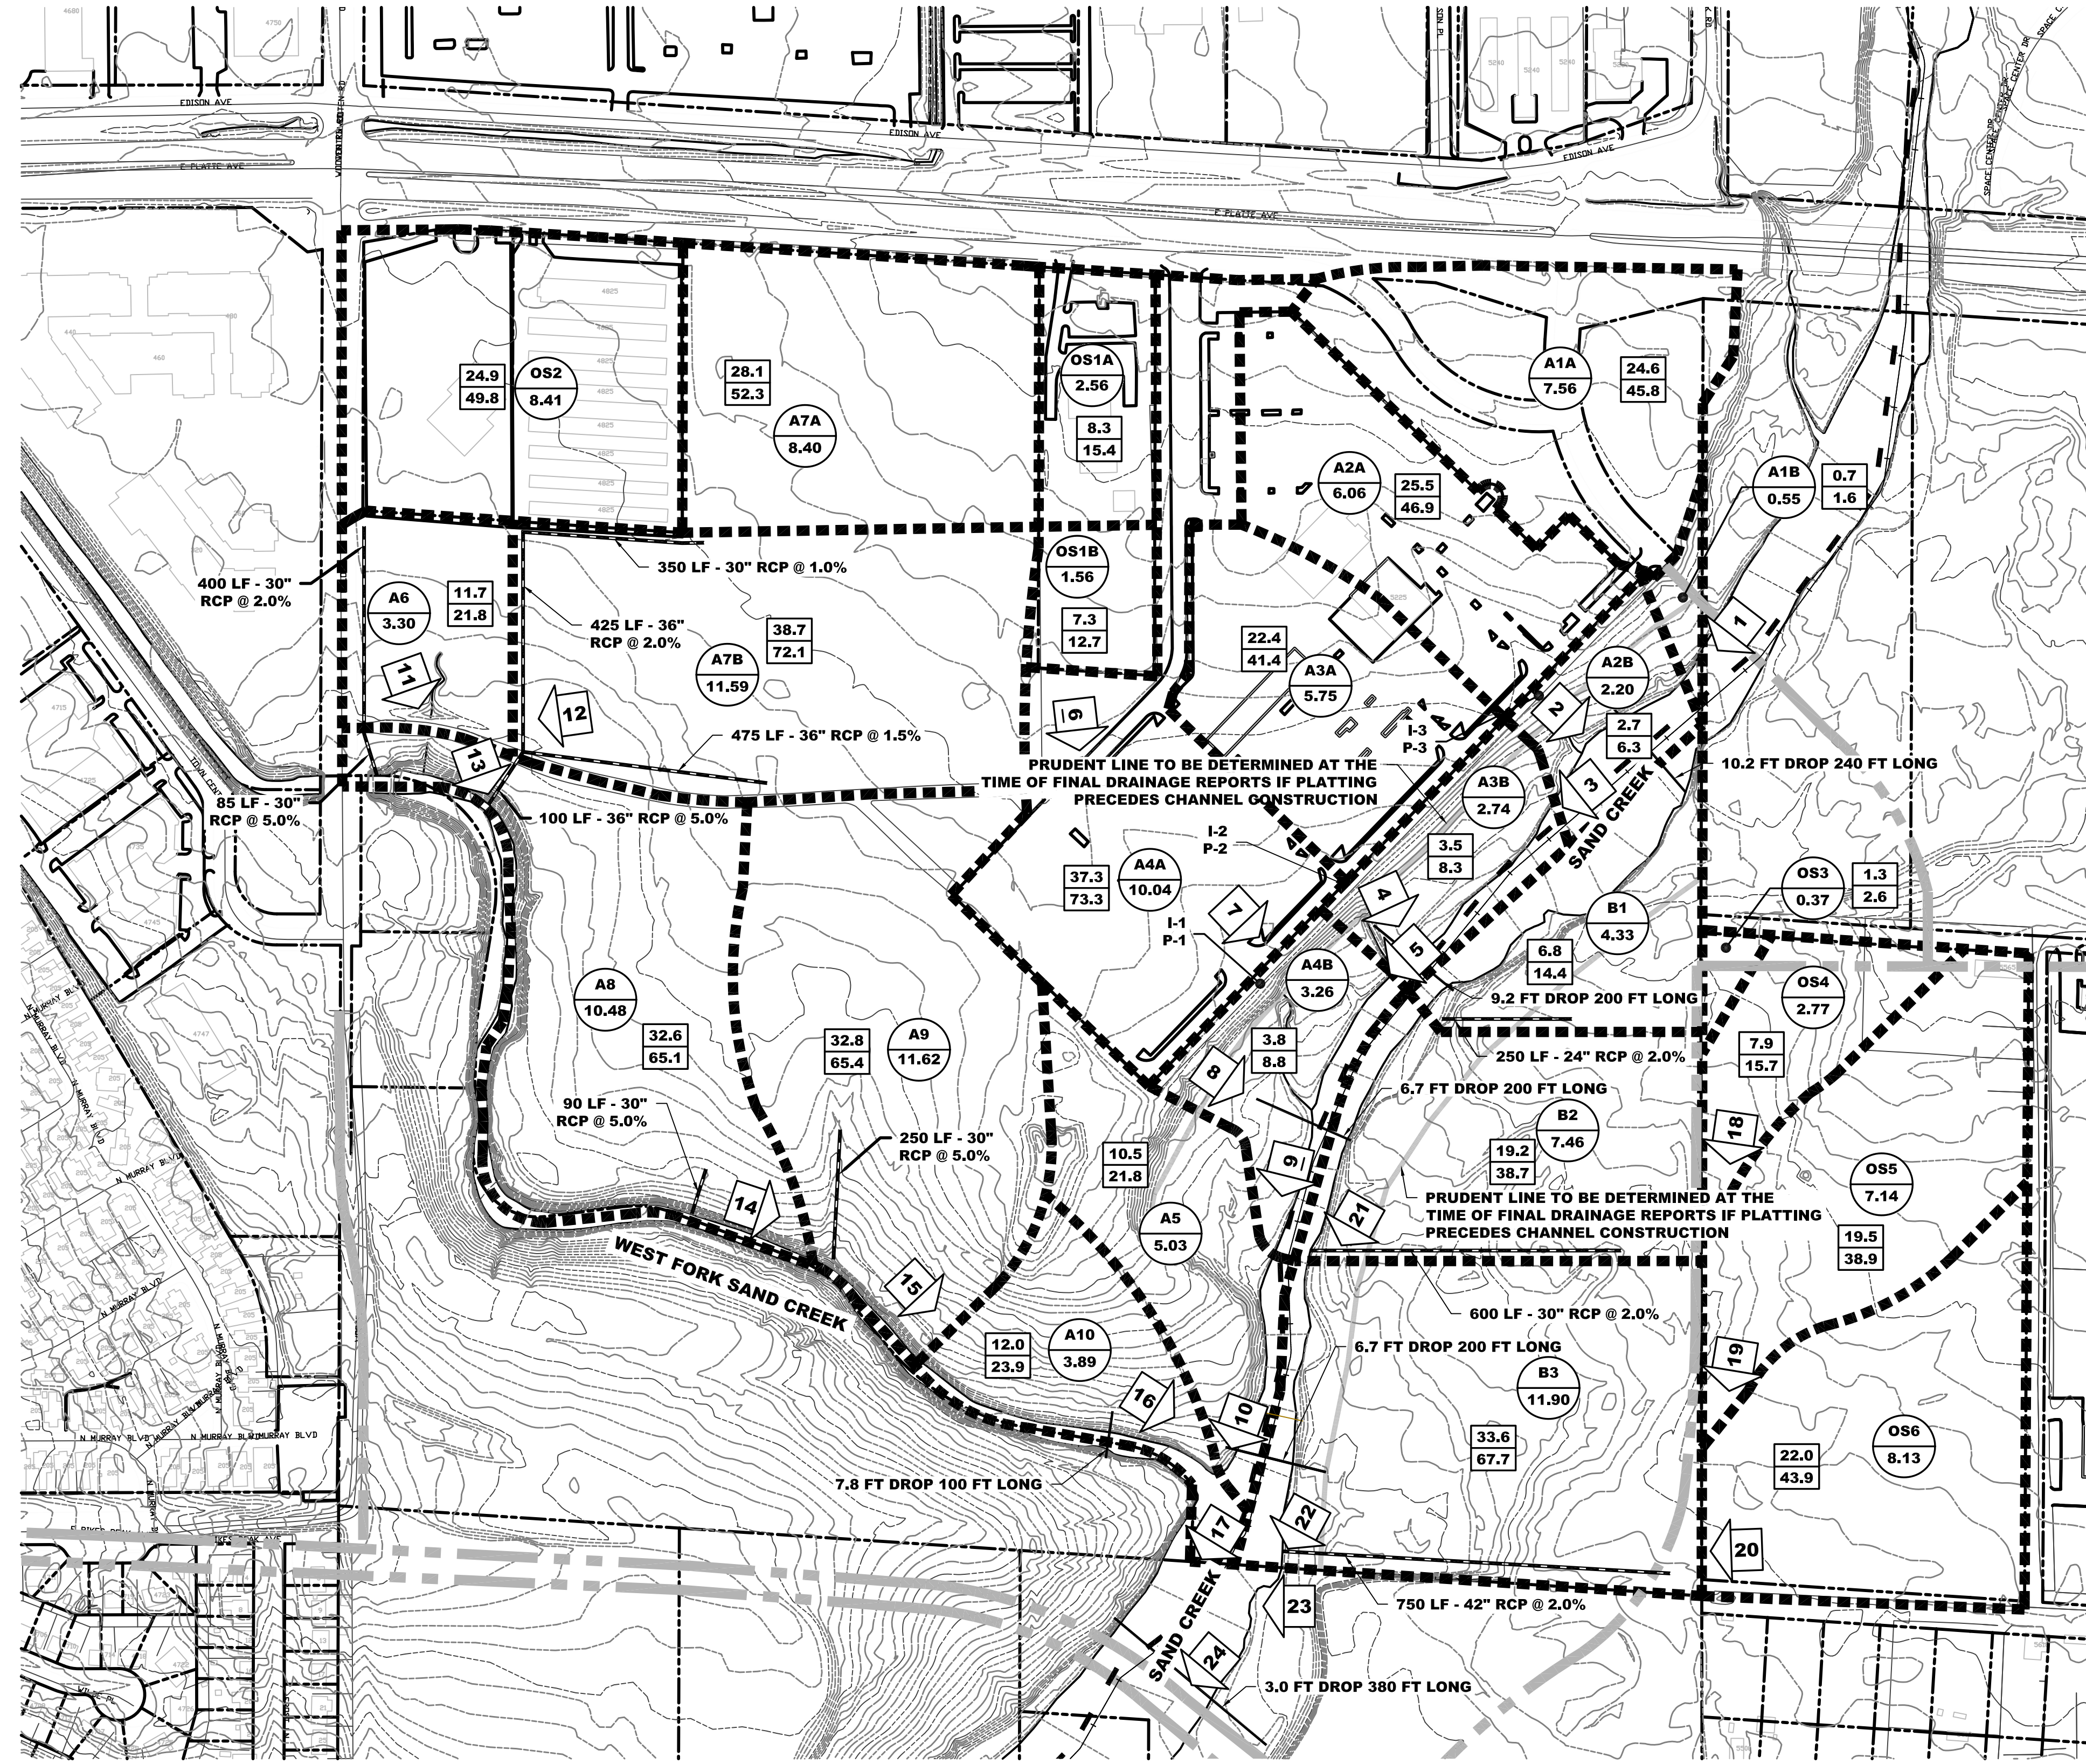


LEGEND

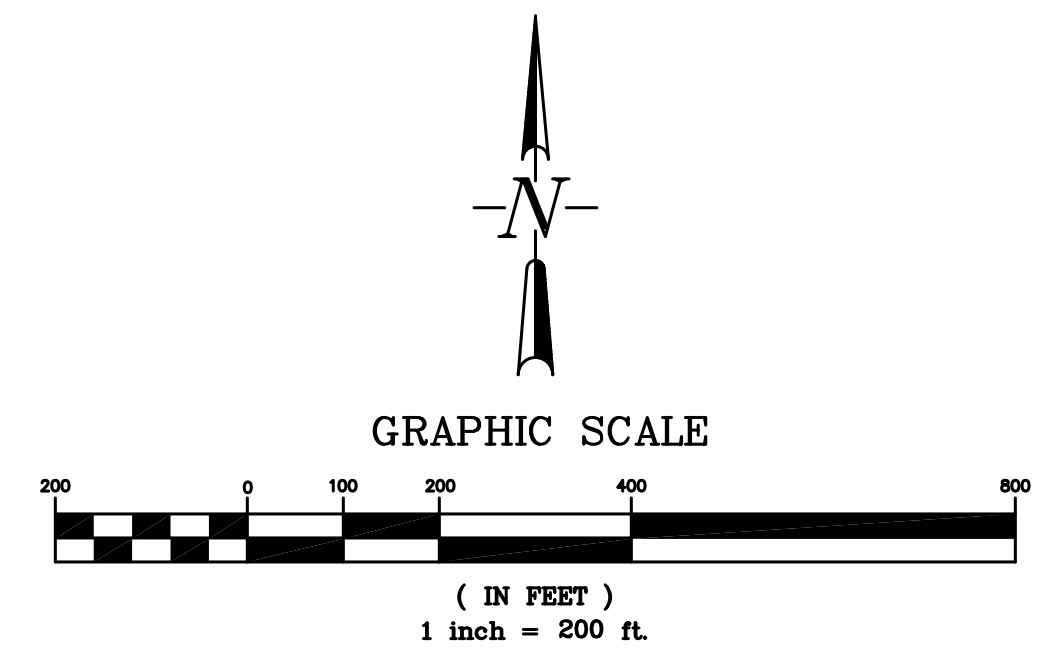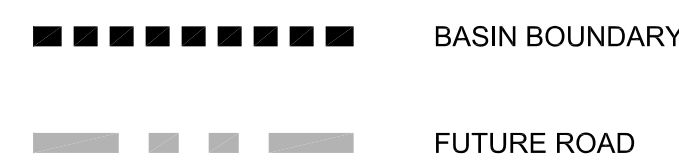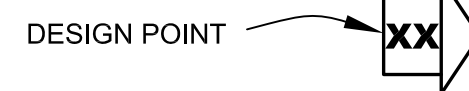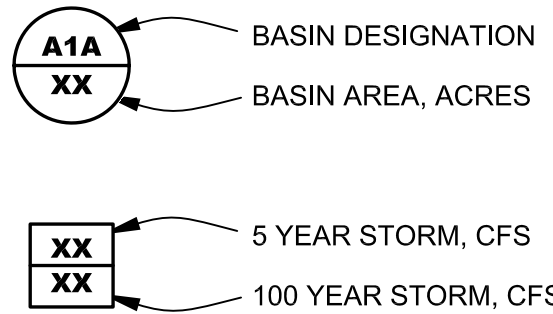

DESIGNED BY: MAB
 PROJECT ENGINEER: MAB
 JOB NO.: 080701
 DATE: 3/12/12
 PROJECT MANAGER: MAB
 CAD FILE NO.: DRAINAGE.dwg
 DRAWN BY: SMH
 SCALE: 1"=200'
 HORIZ.: 1/2"=100'
 VERT.: 1/4"=10'

PREPARED BY:

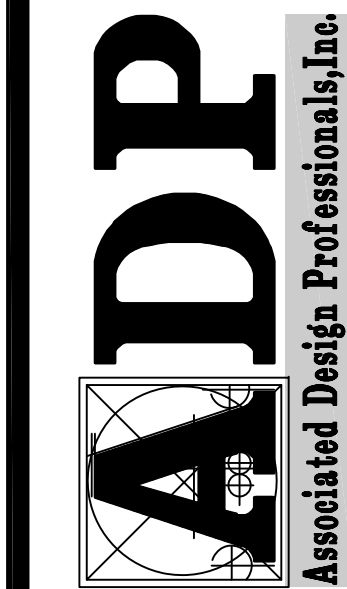

3620 Austin Bluffs Parkway
 Suite 200
 Colorado Springs, CO 80918
 (719) 586-5212
 fax: (719) 586-5341

NO.	DATE	REVISION	BY

MASTER DEVELOPMENT DRAINAGE PLAN
CLOUD FAMILY PARTNERSHIP PROPERTY
CITY OF COLORADO SPRINGS, COLORADO
DEVELOPED DRAINAGE CONDITIONS