


EXIST. 6' x 2.5' x 15.5' RCB
CAP = 258 CFS

SCALE 1" = 100'
CONTOUR INTERVAL 2 FEET

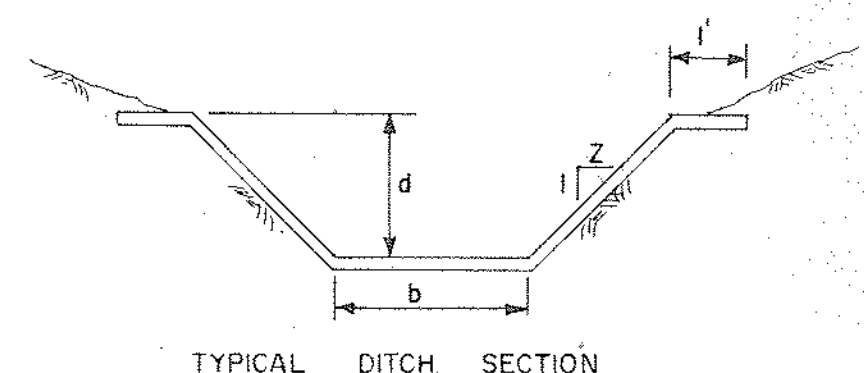

SEE PLATE NO. 5 FOR CROSS-SECTIONS


**VAN BUREN VII
DRAINAGE PLAN (CITY CRITERIA)**
























- A ——— MAJOR BASIN LIMITS
- F6 - - - MINOR BASIN LIMITS
- ⊗ 4 HYDROGRAPH POINT
- 50 YR. 6 HOUR FLOOD PLAIN LIMITS
- EXISTING STRUCTURES
- EXISTING DIP SLABS
- 70/40 R.O.W./STREET WIDTH
- 16.5 RUNOFF IN C.F.S. - 50 YR. STORM, I = 2"/1 HR.
- CONC. DITCH
- STORM SEWER
- CATCH BASIN

73-1067
7-21-73

UNITED WESTERN ENGINEERS,
PLATE NO. 3



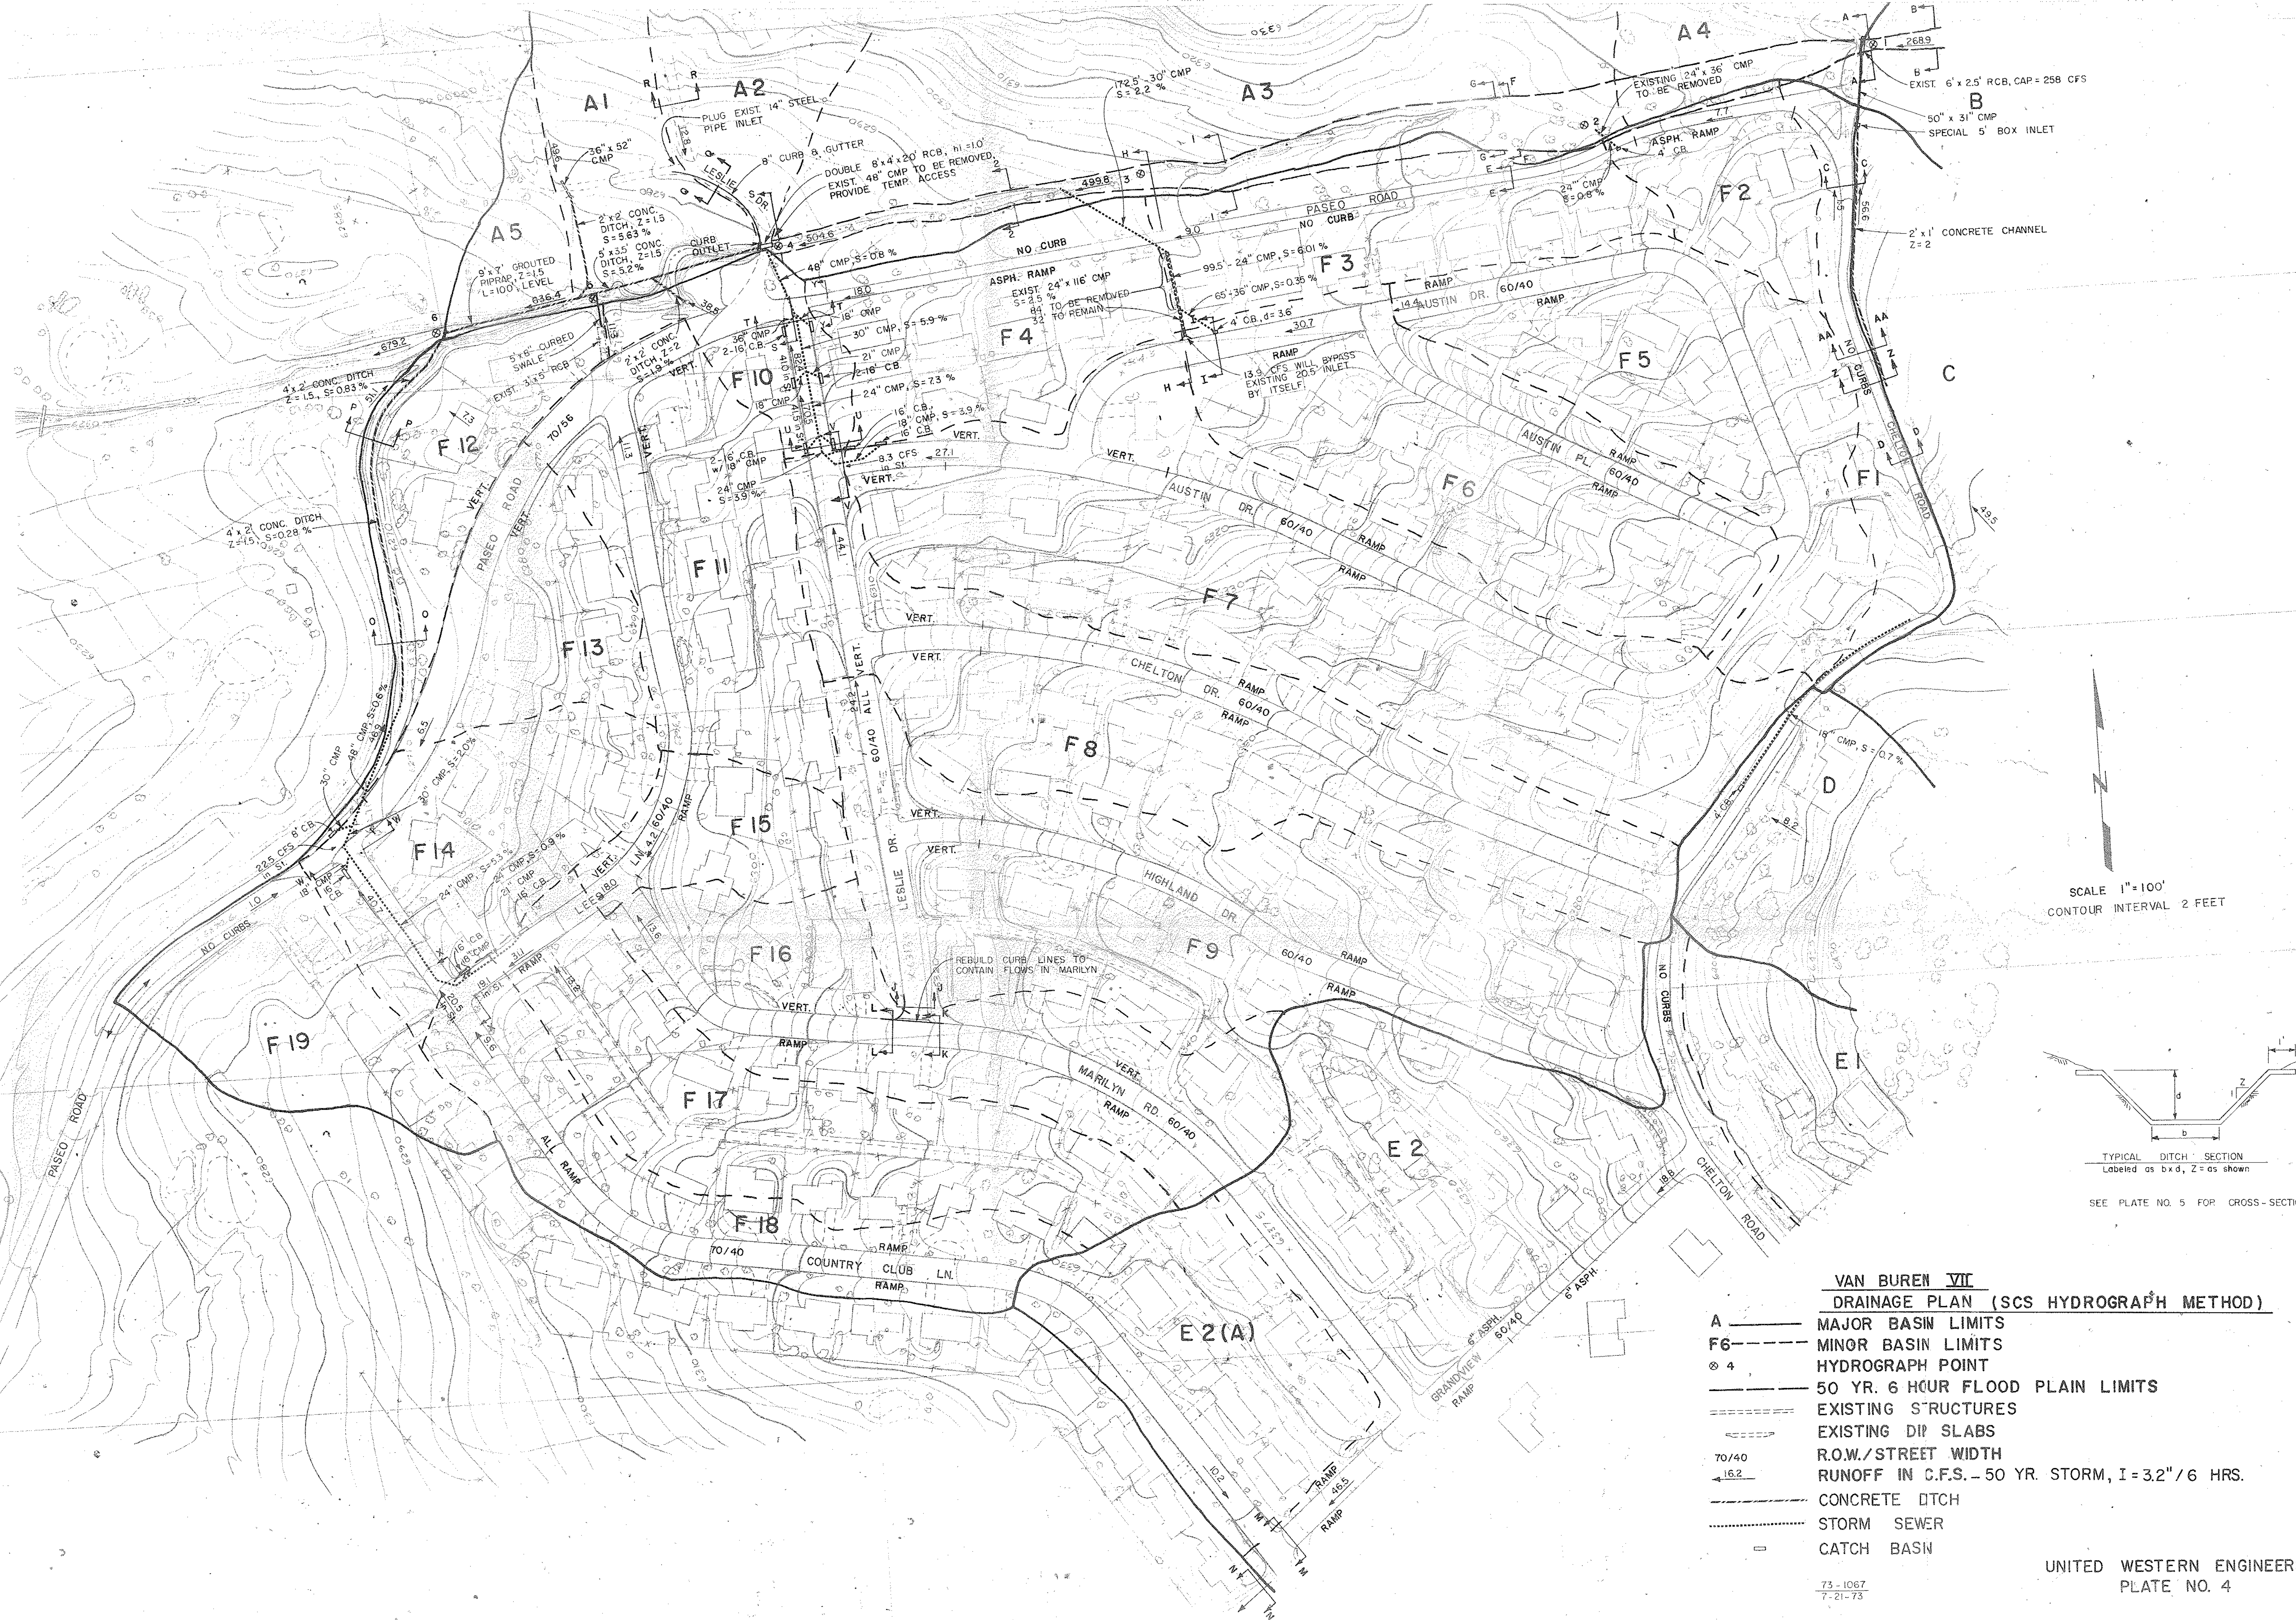

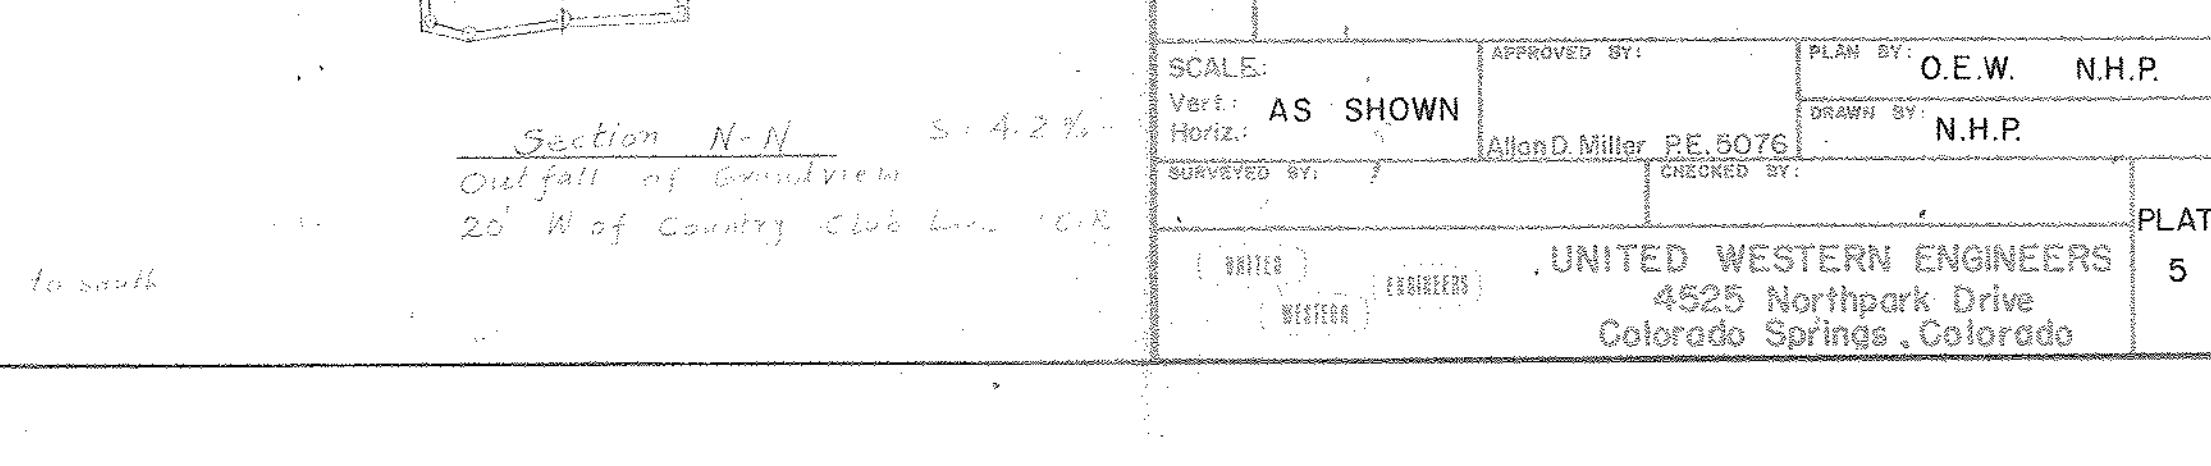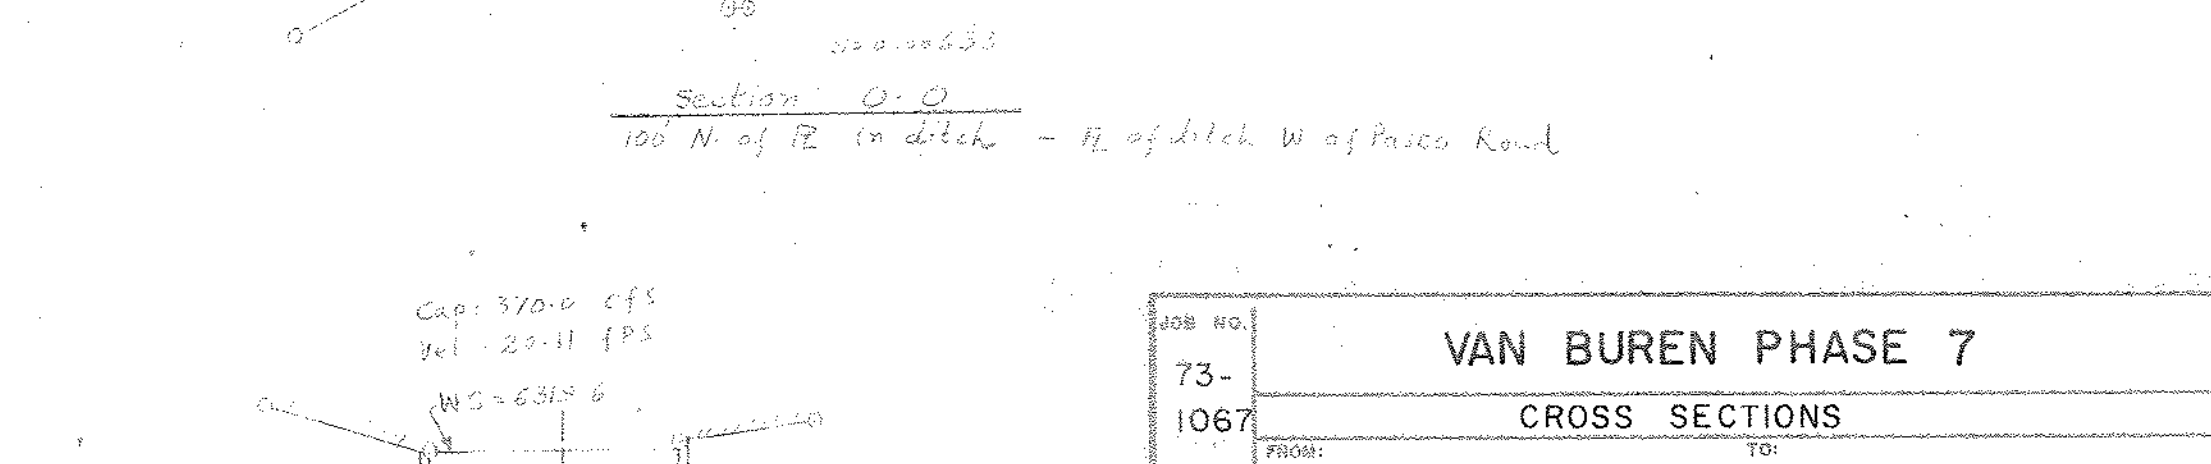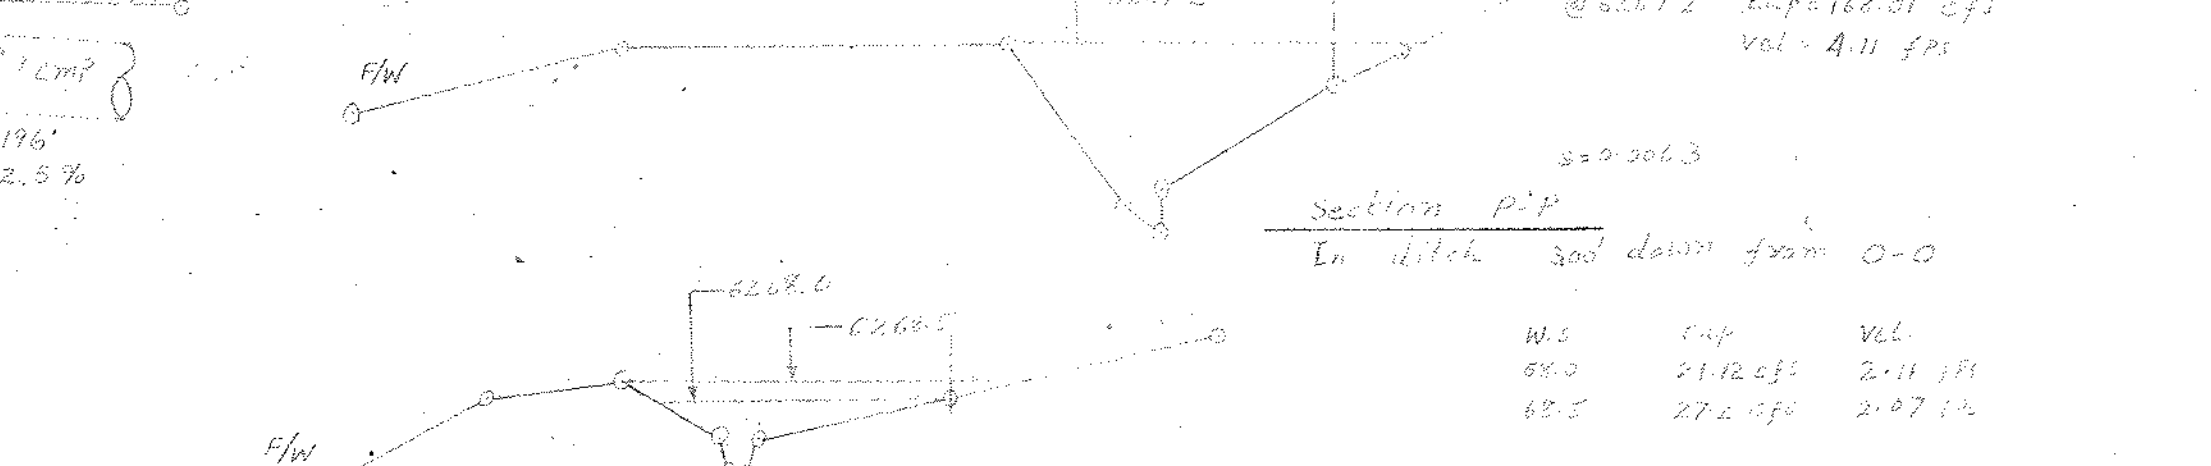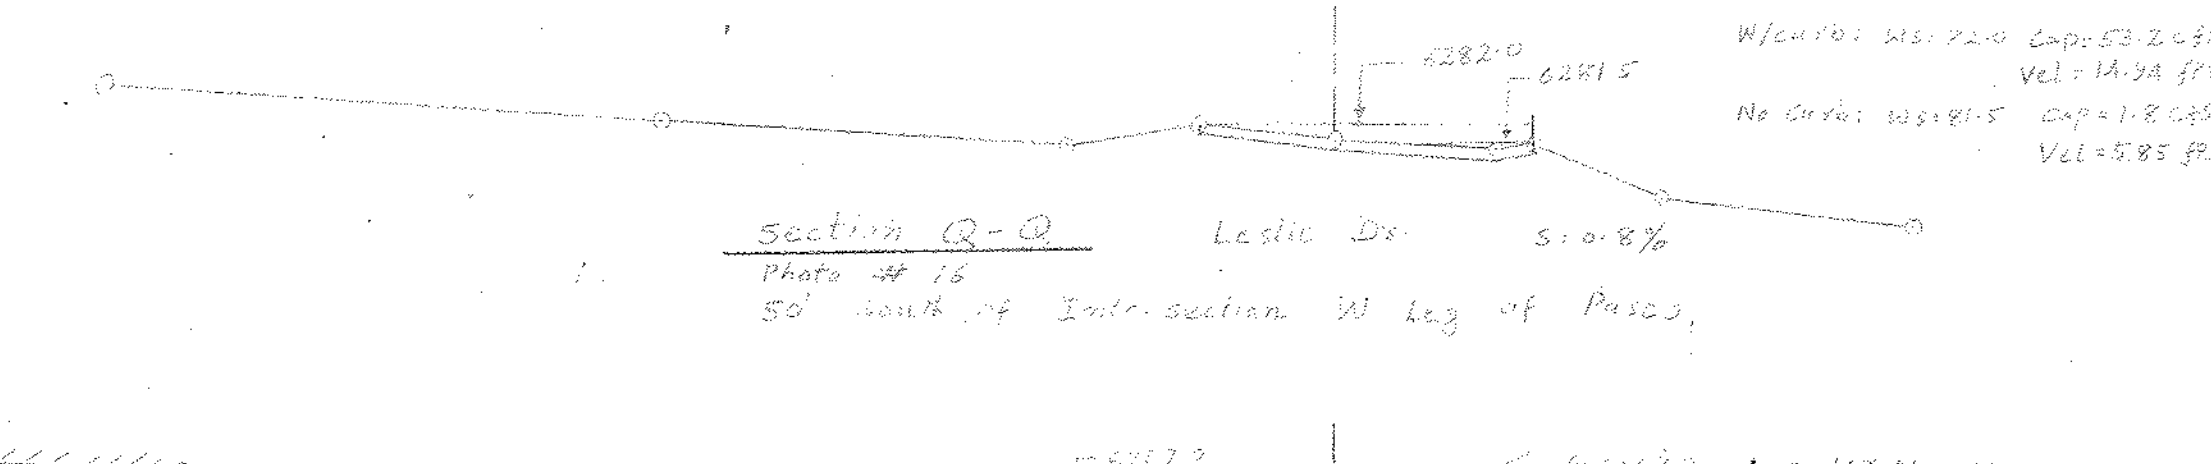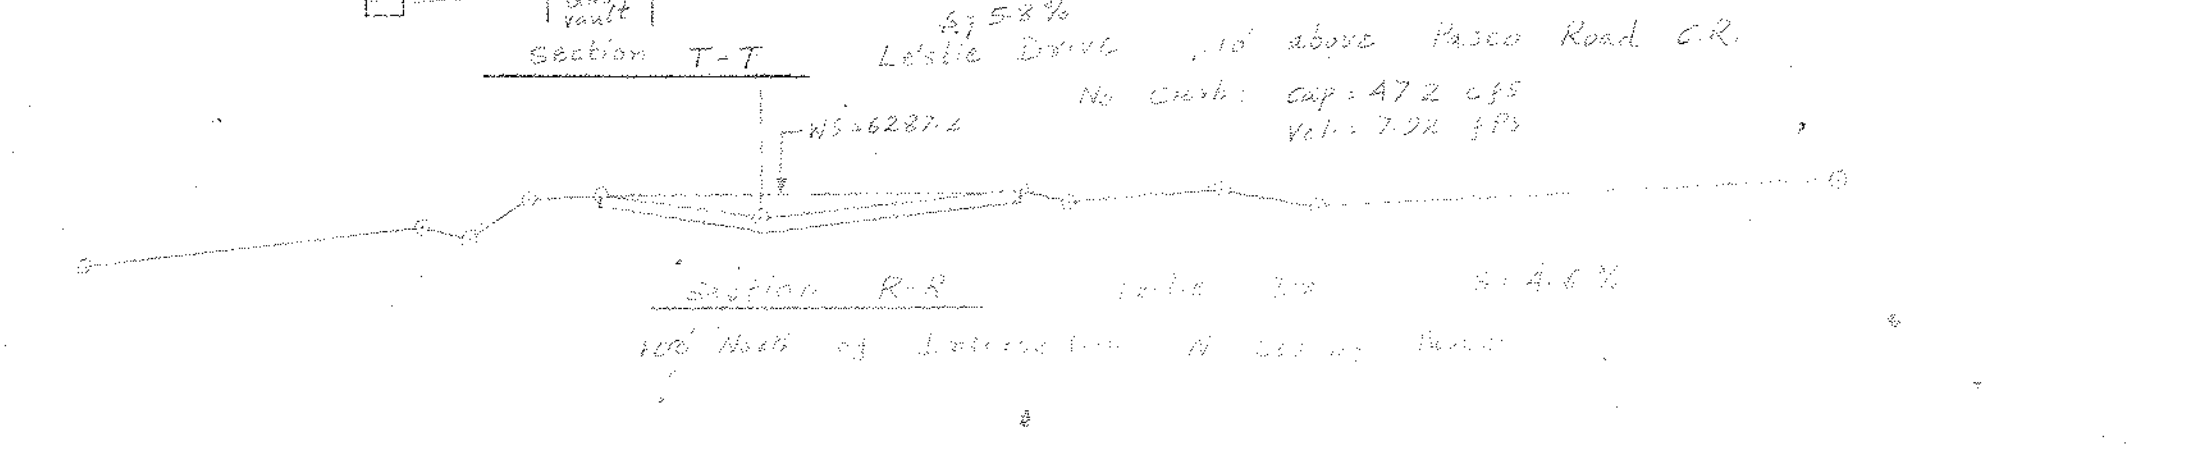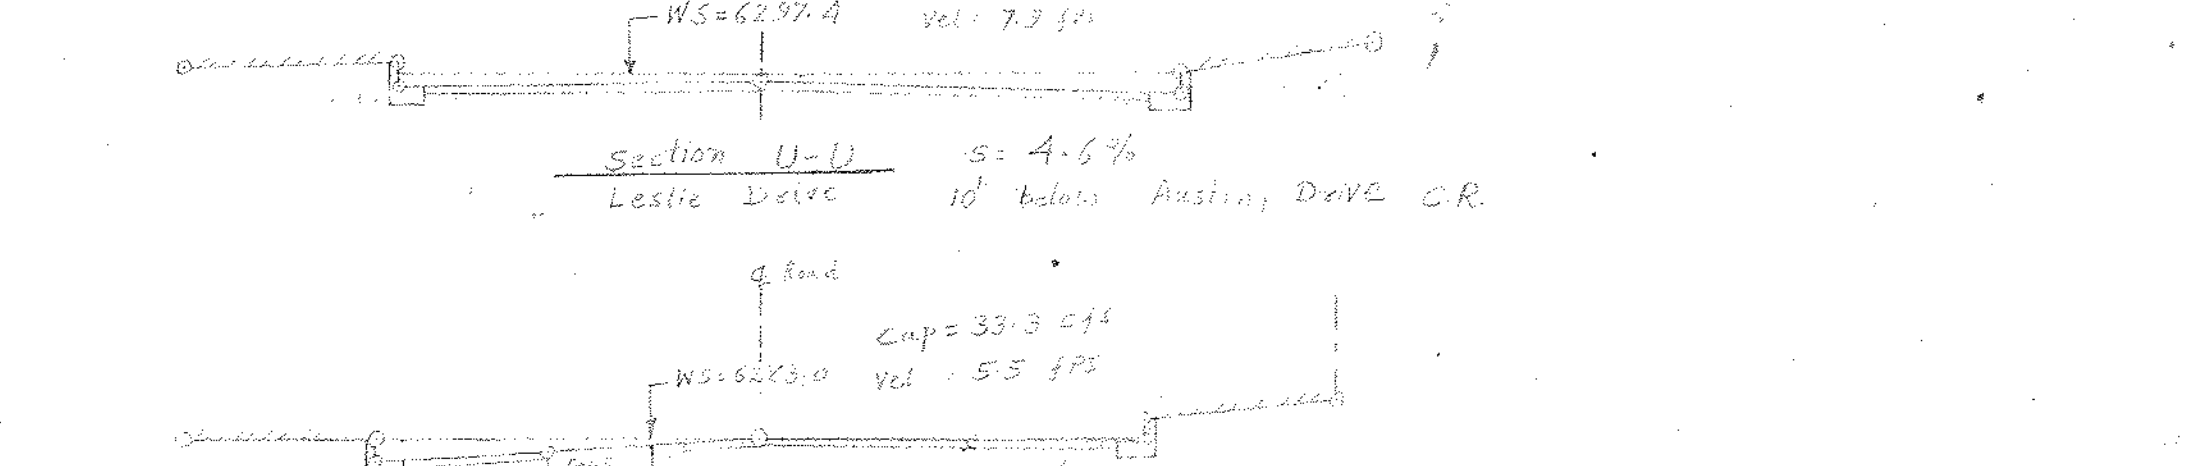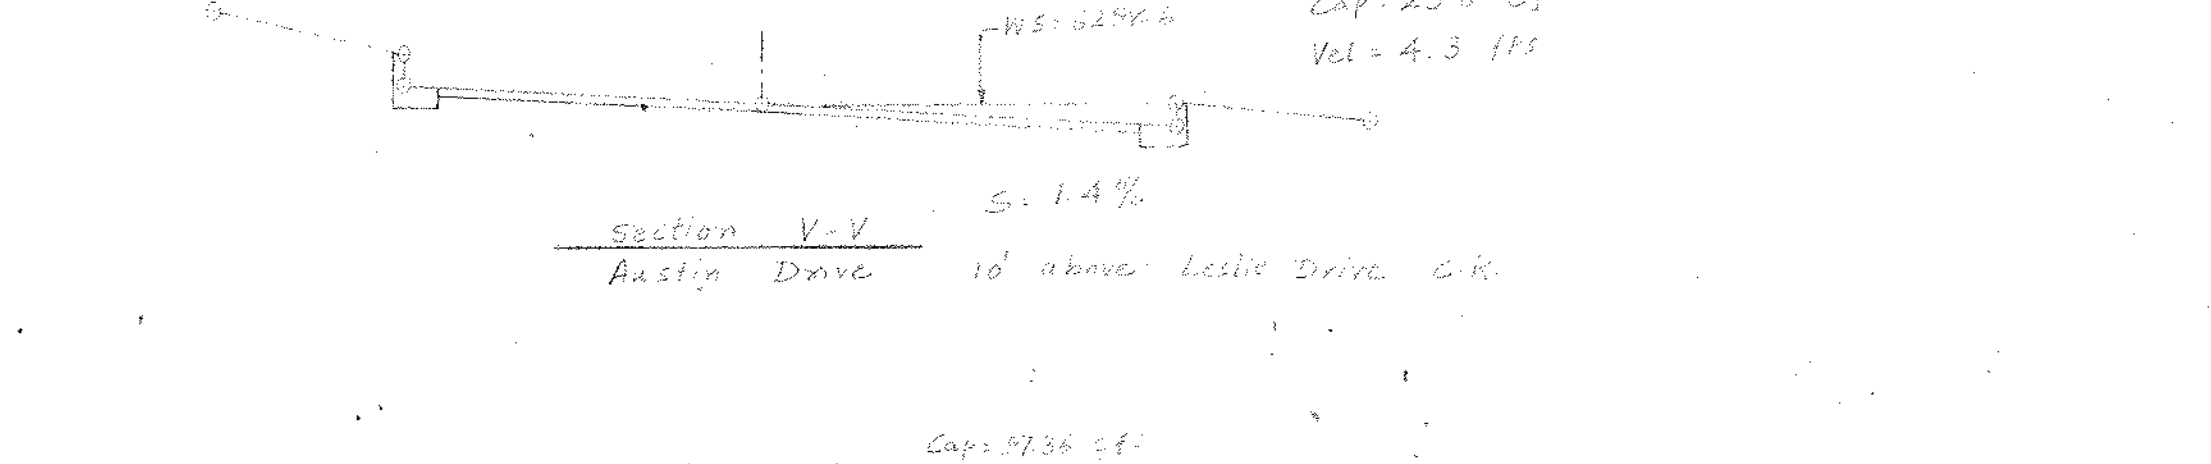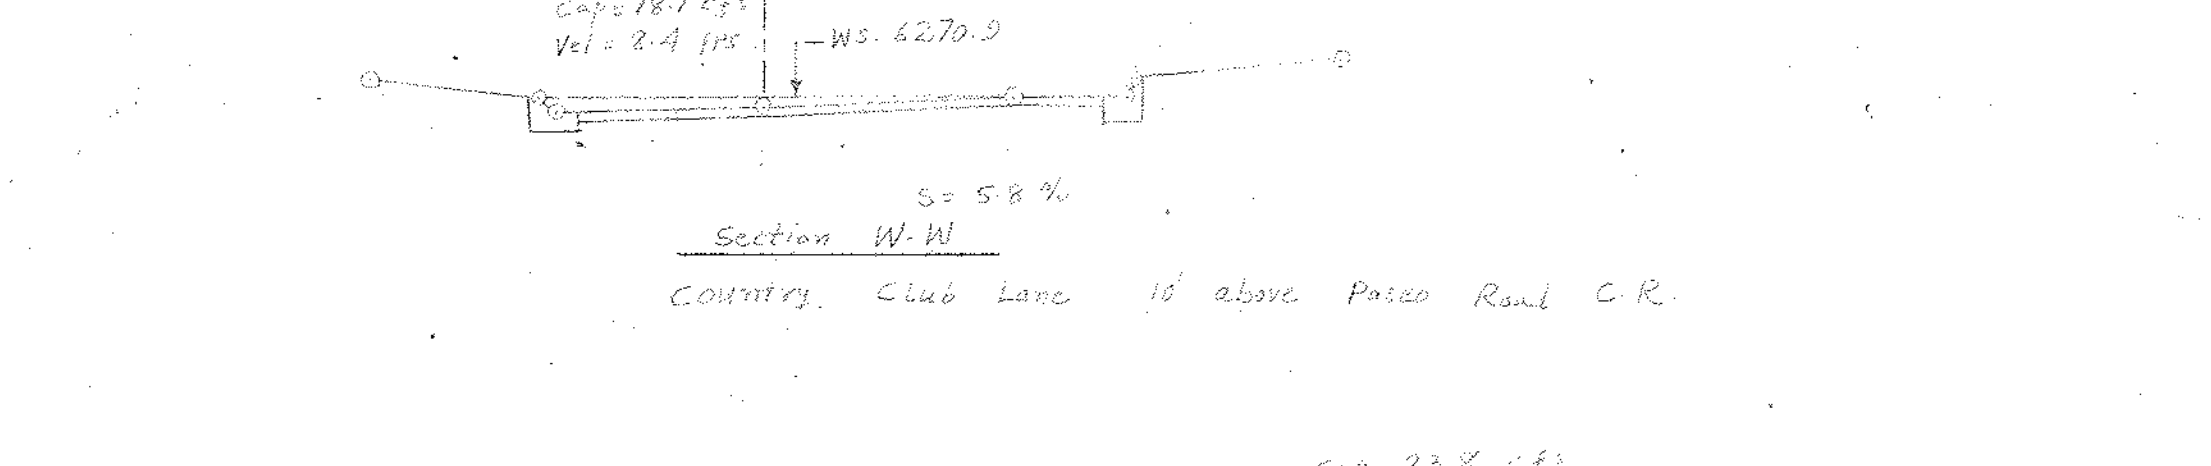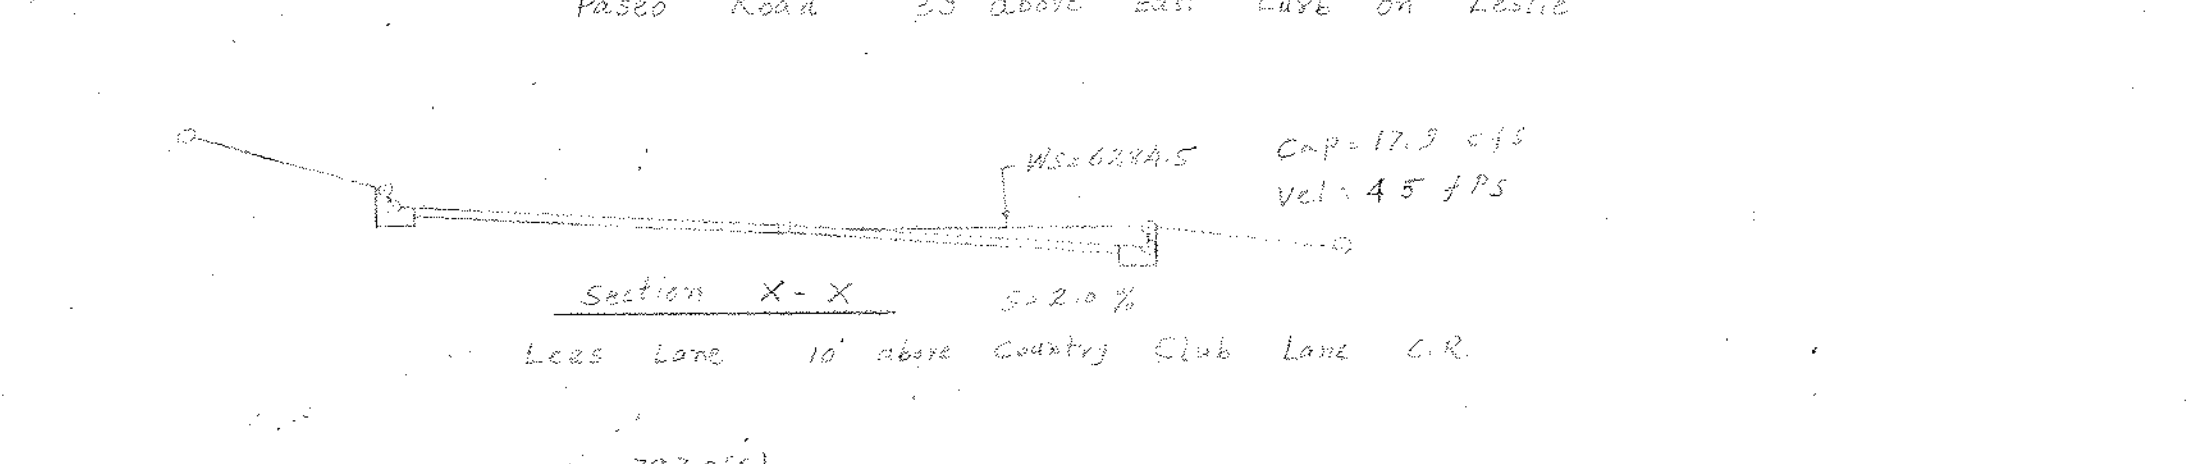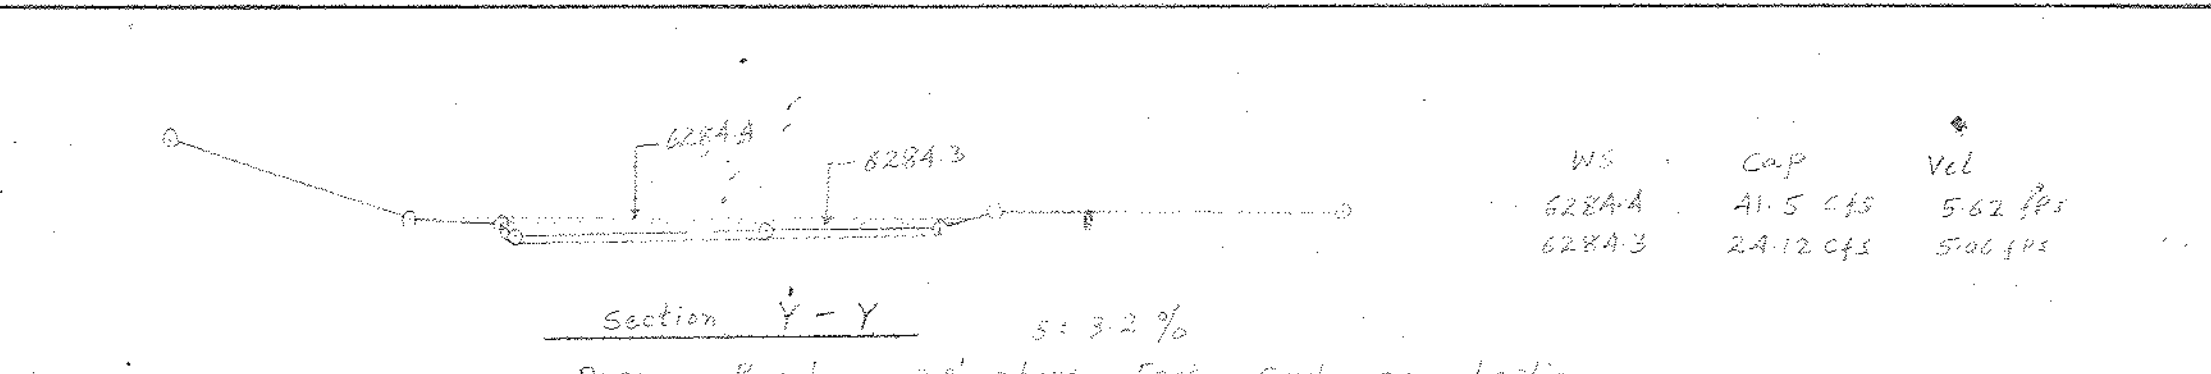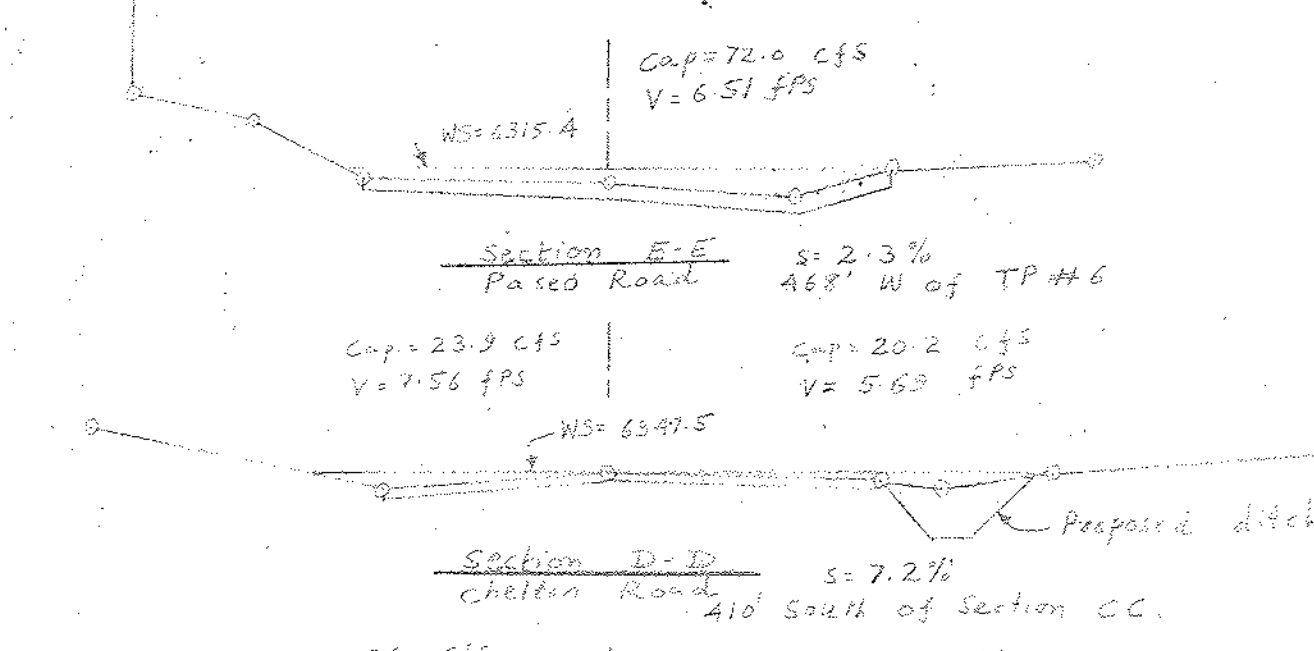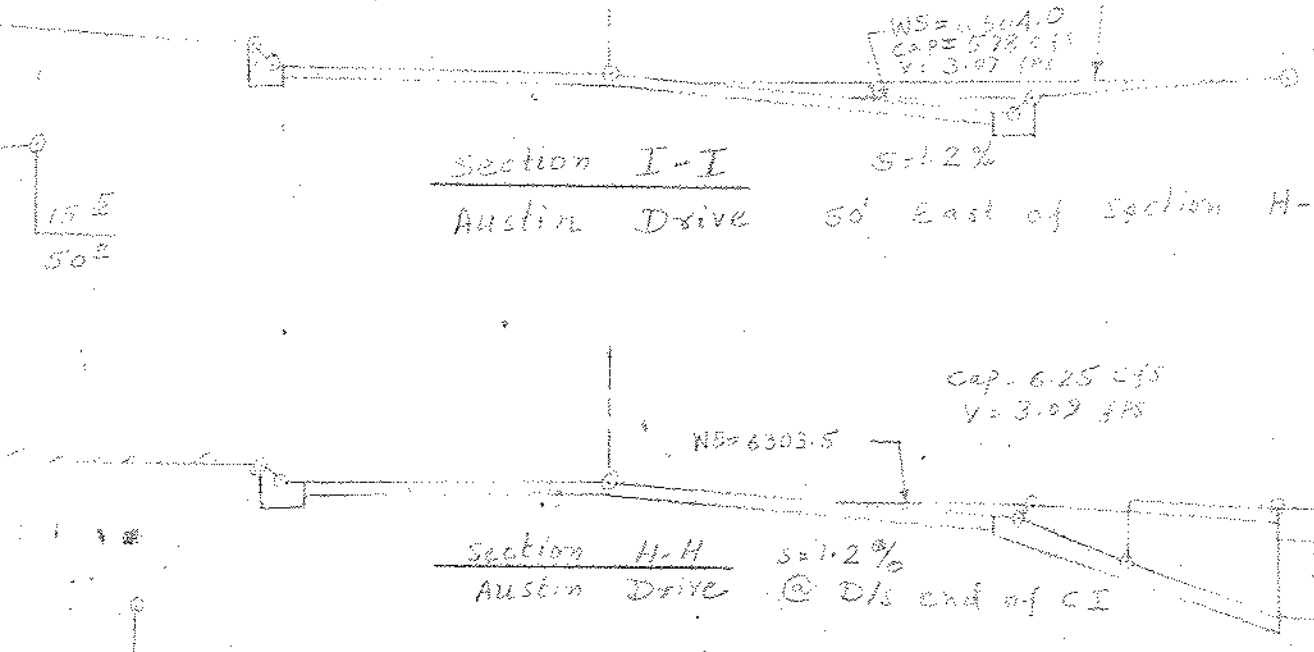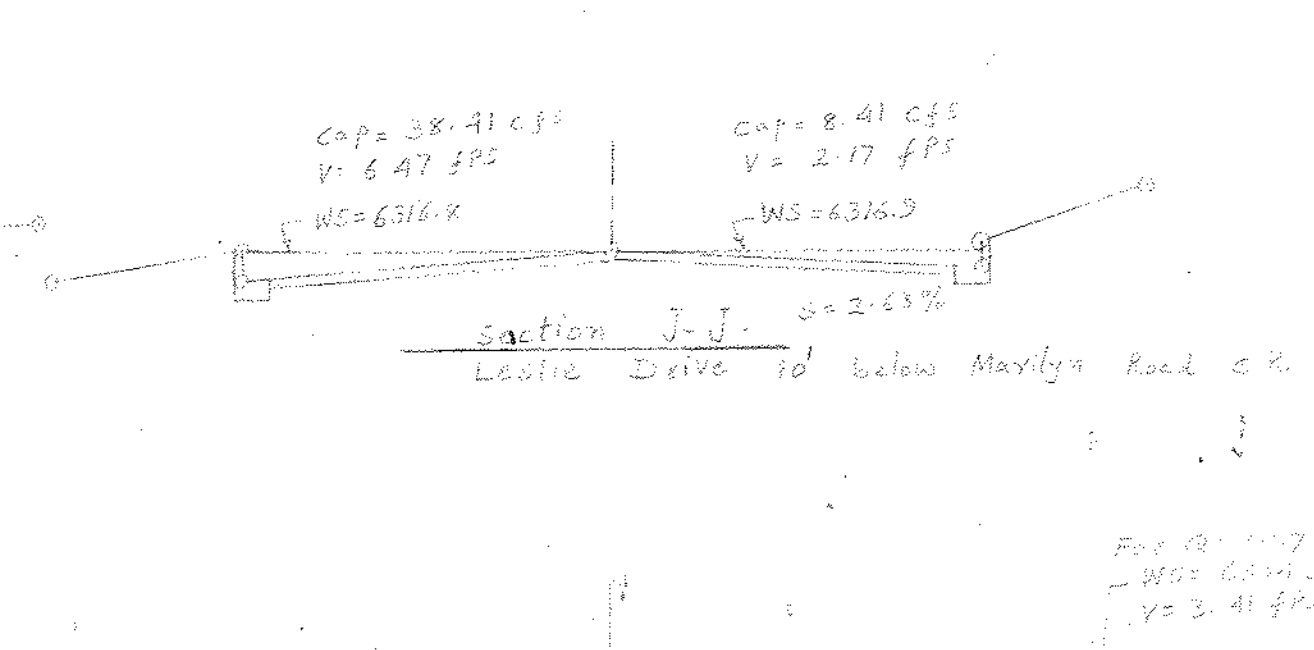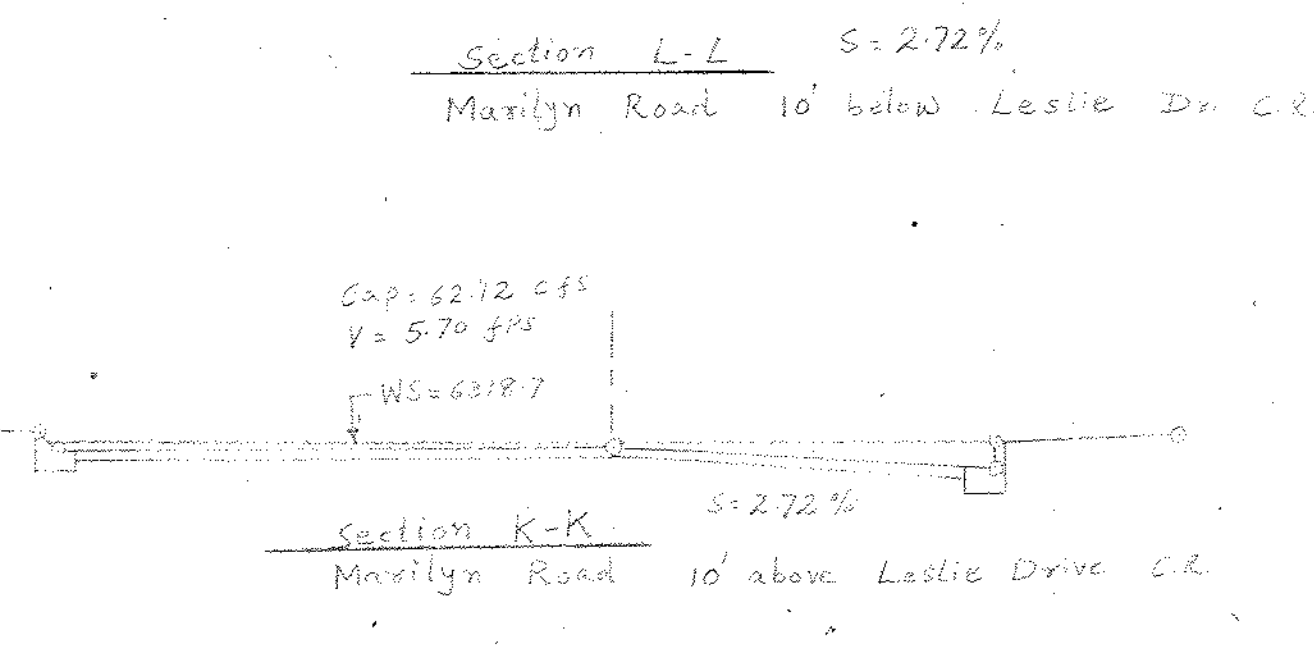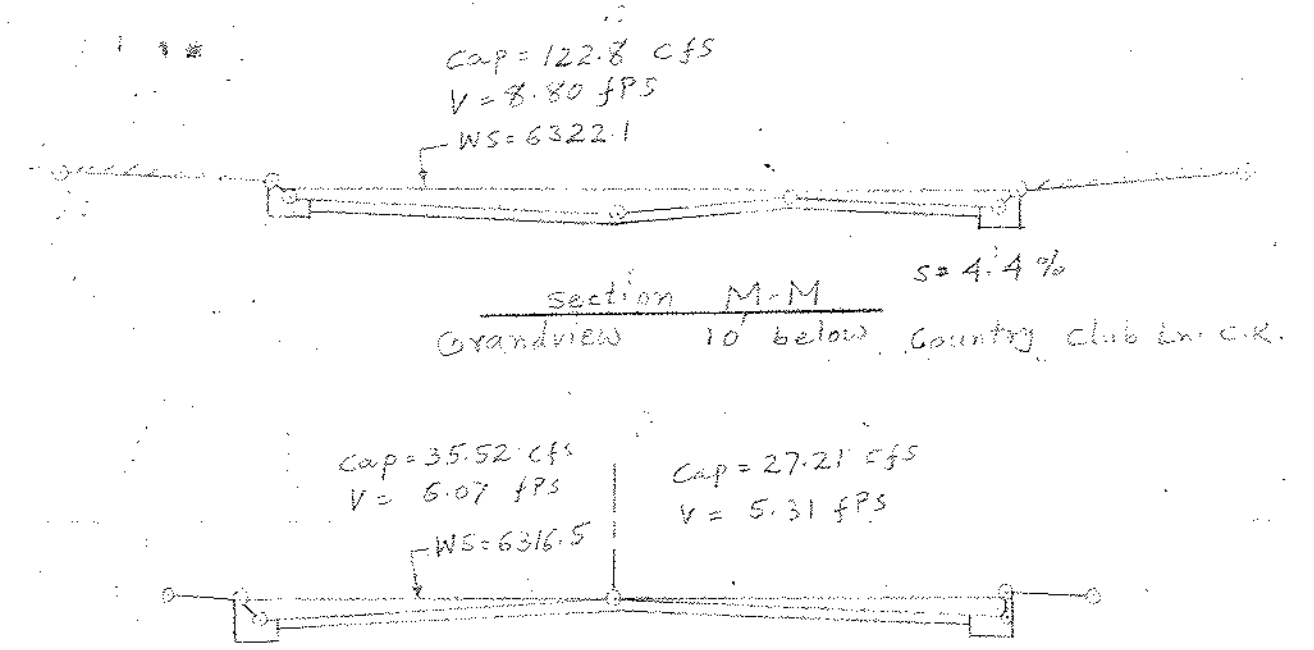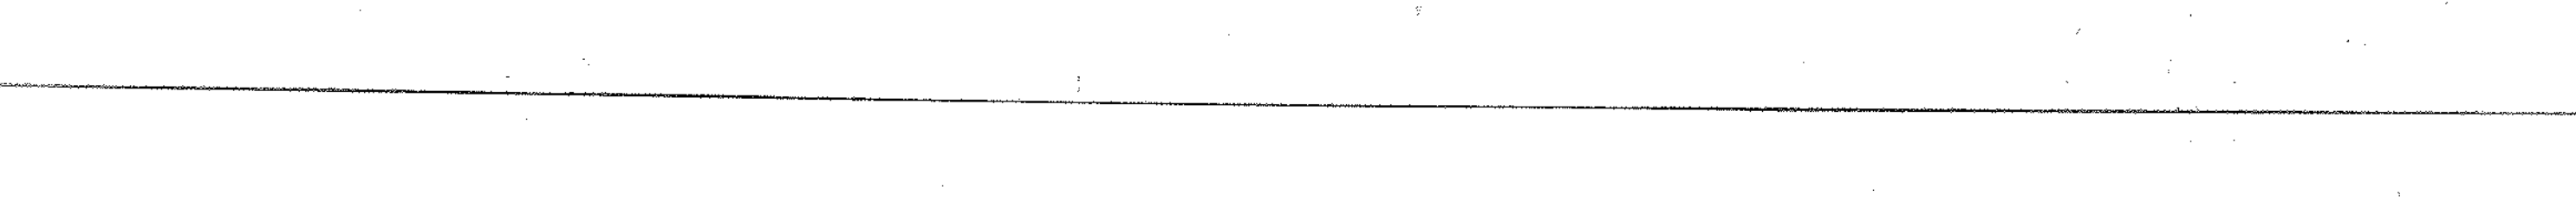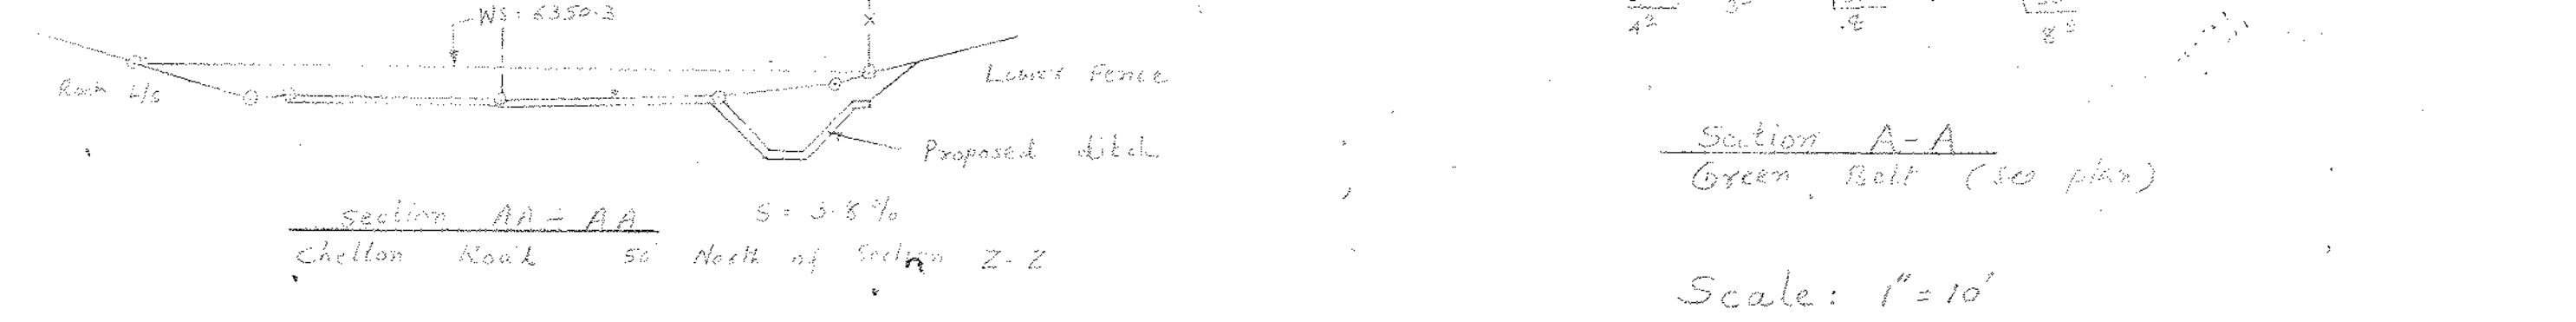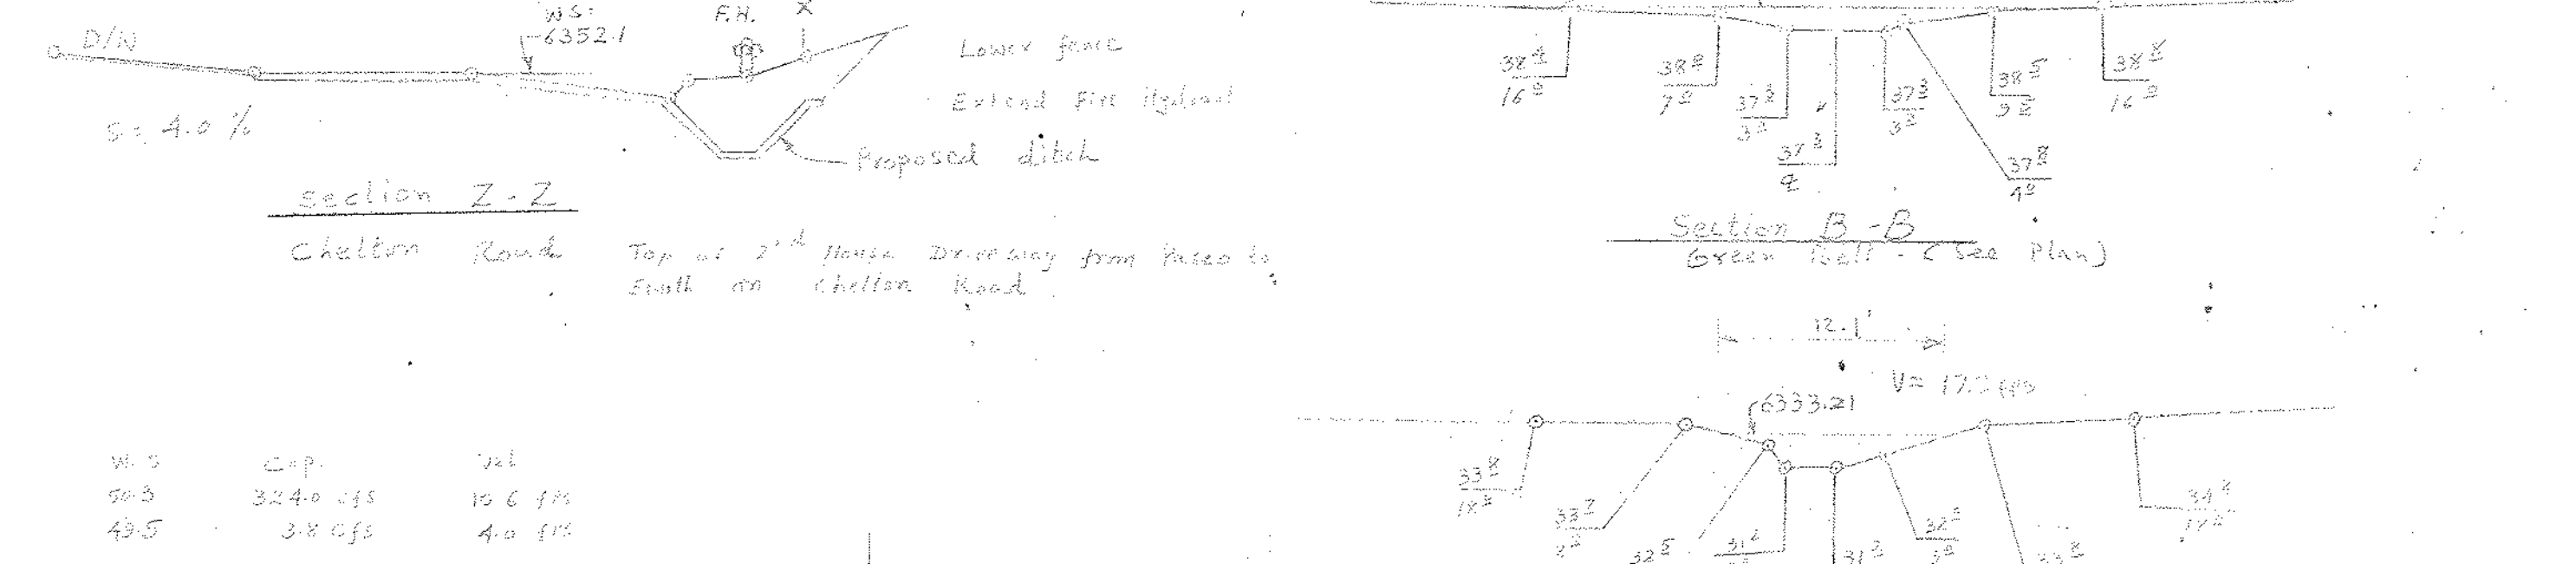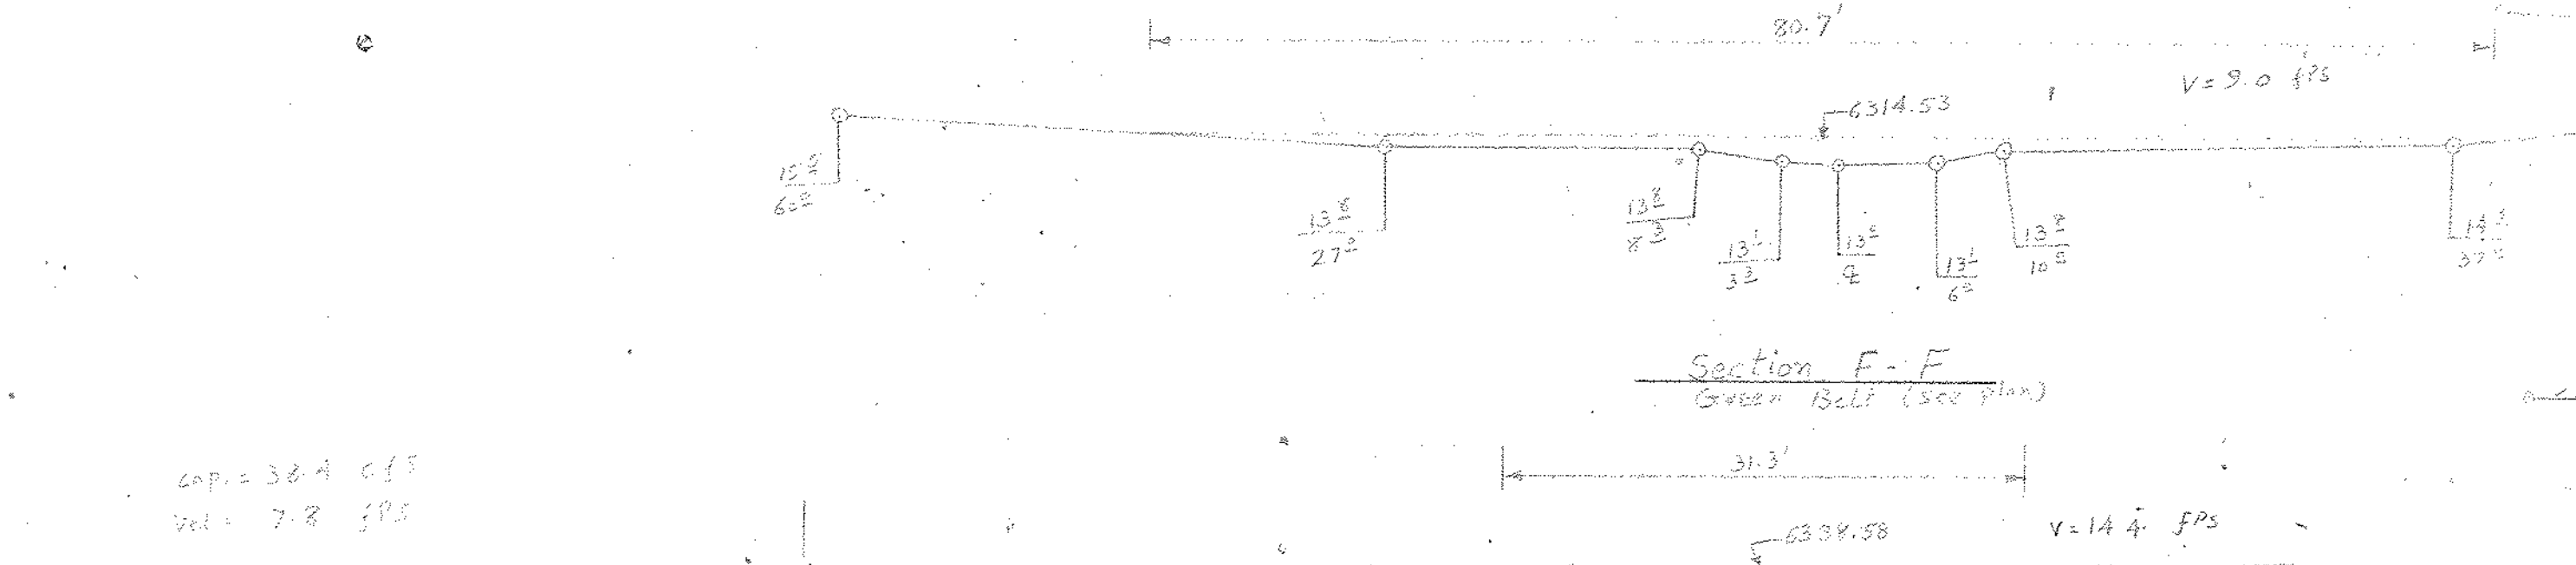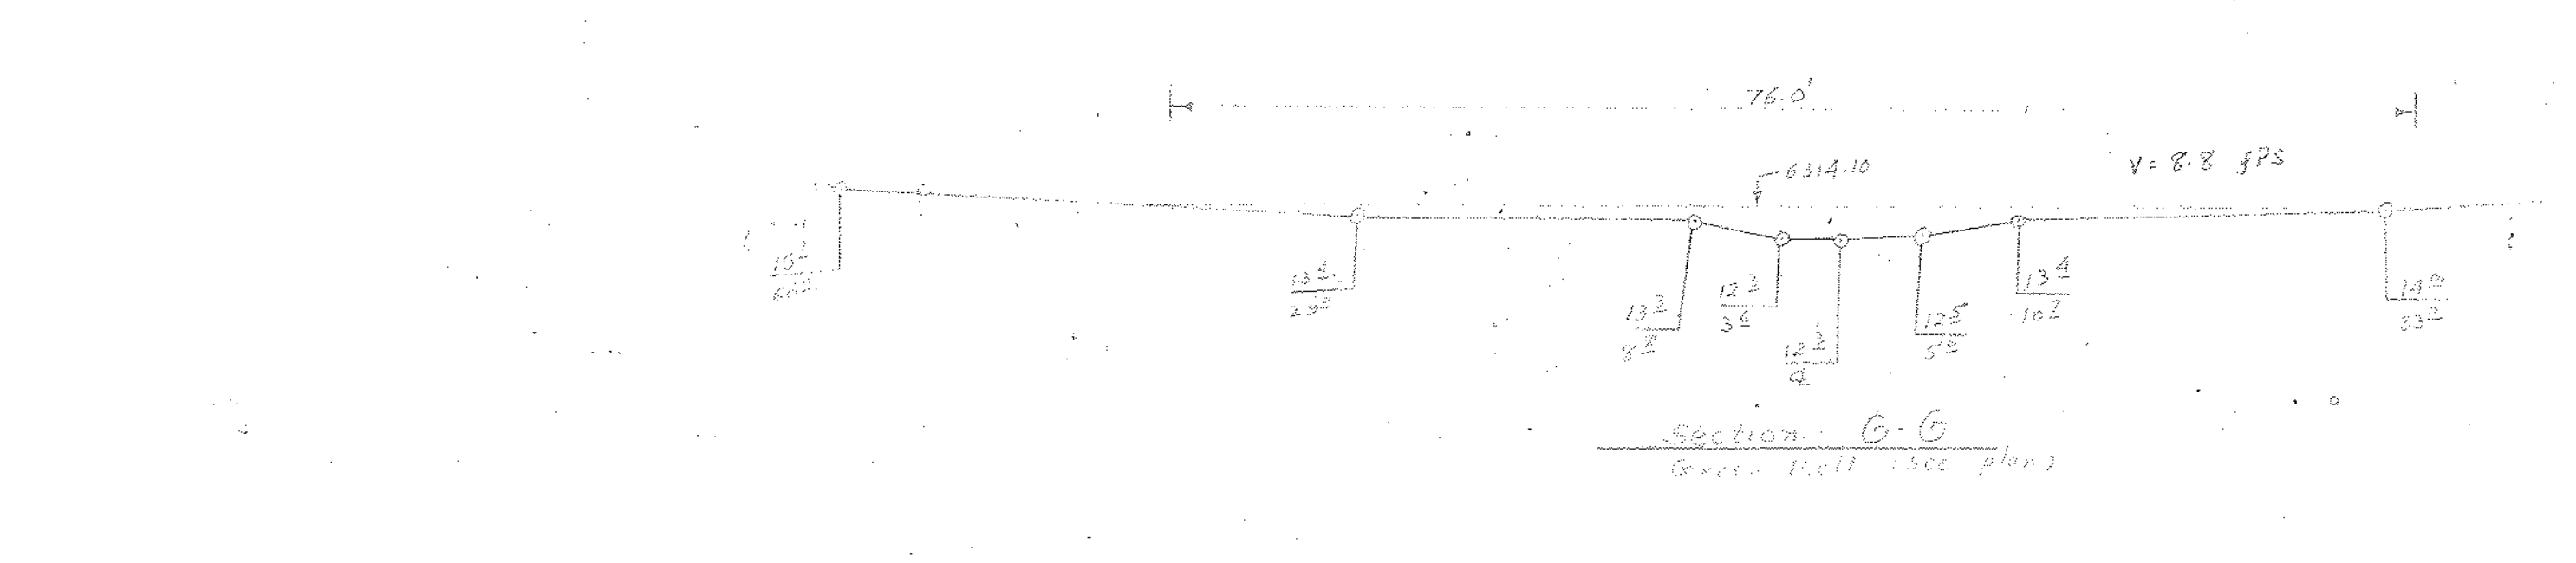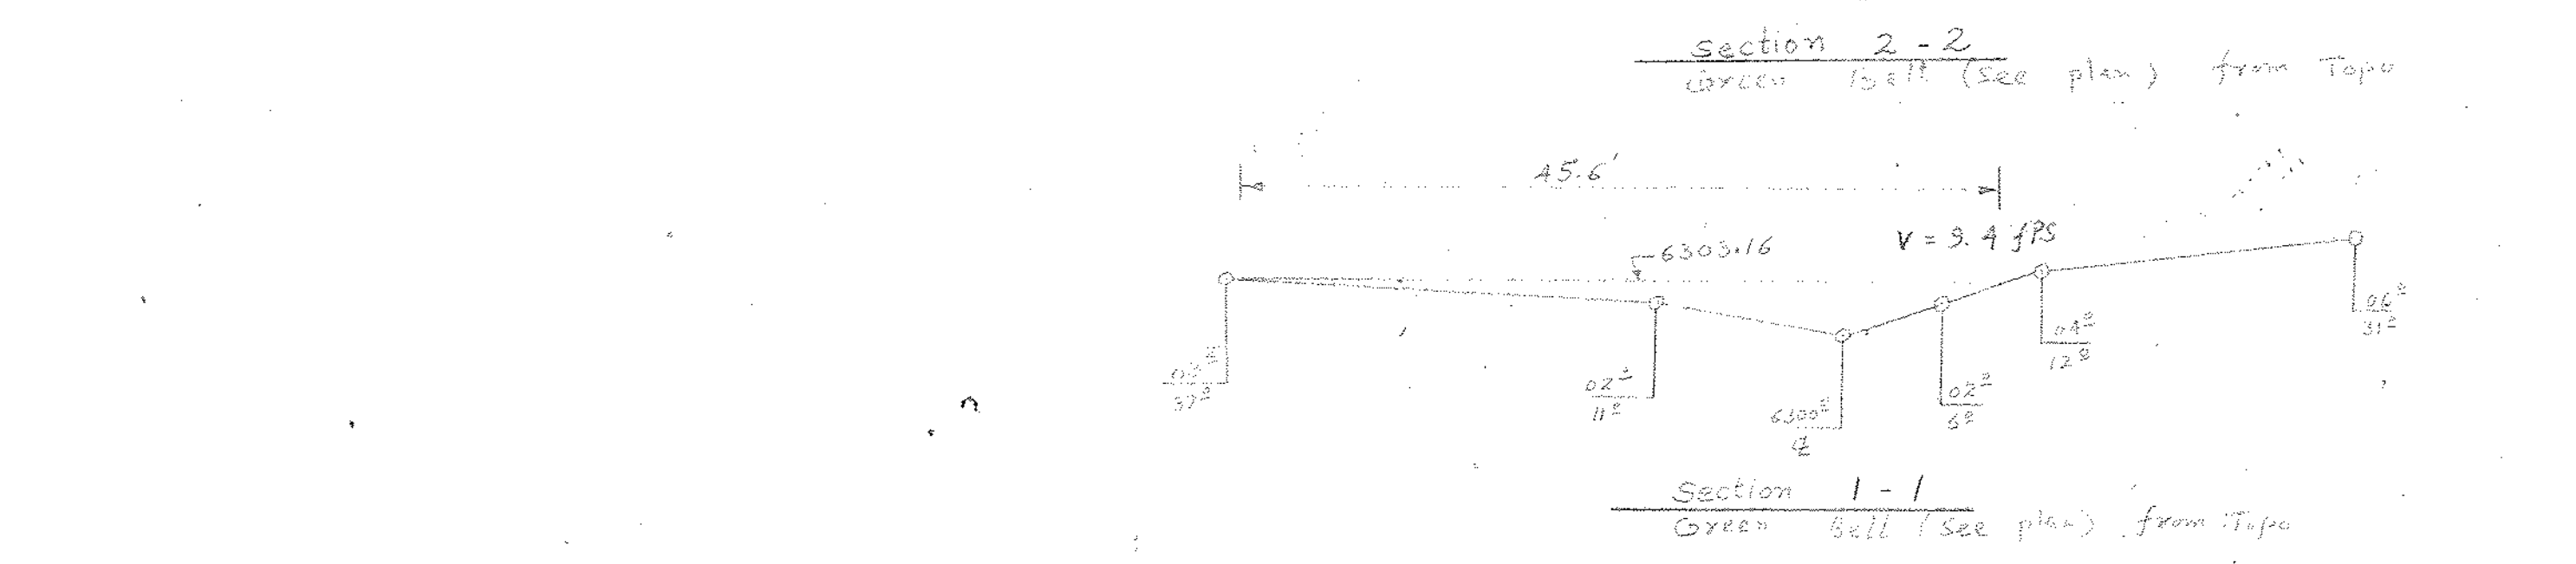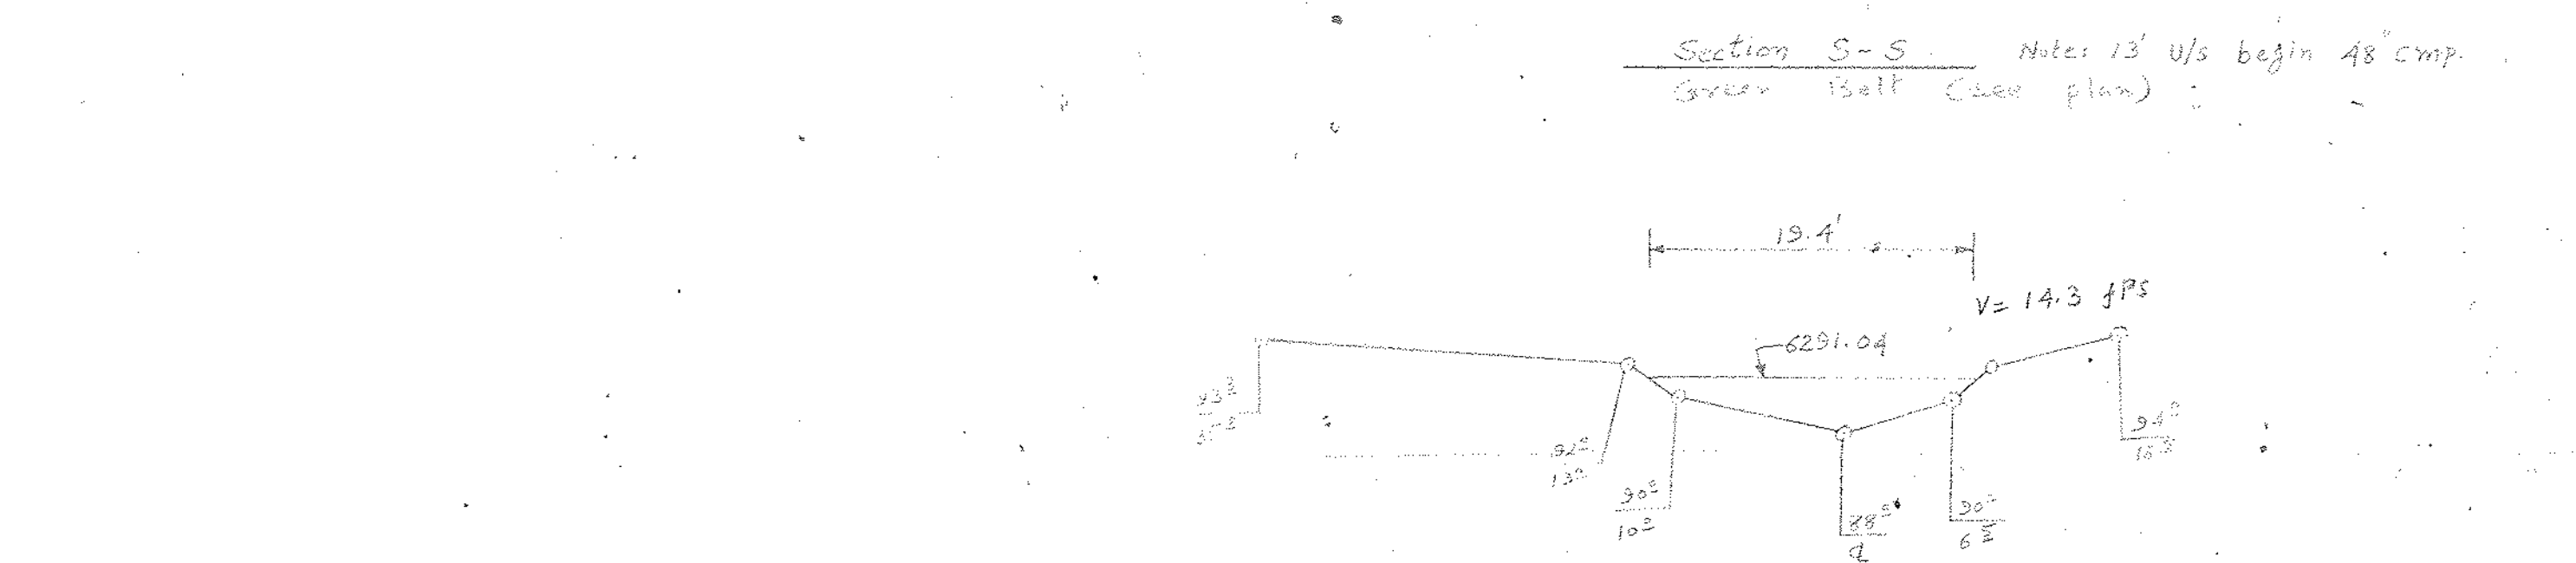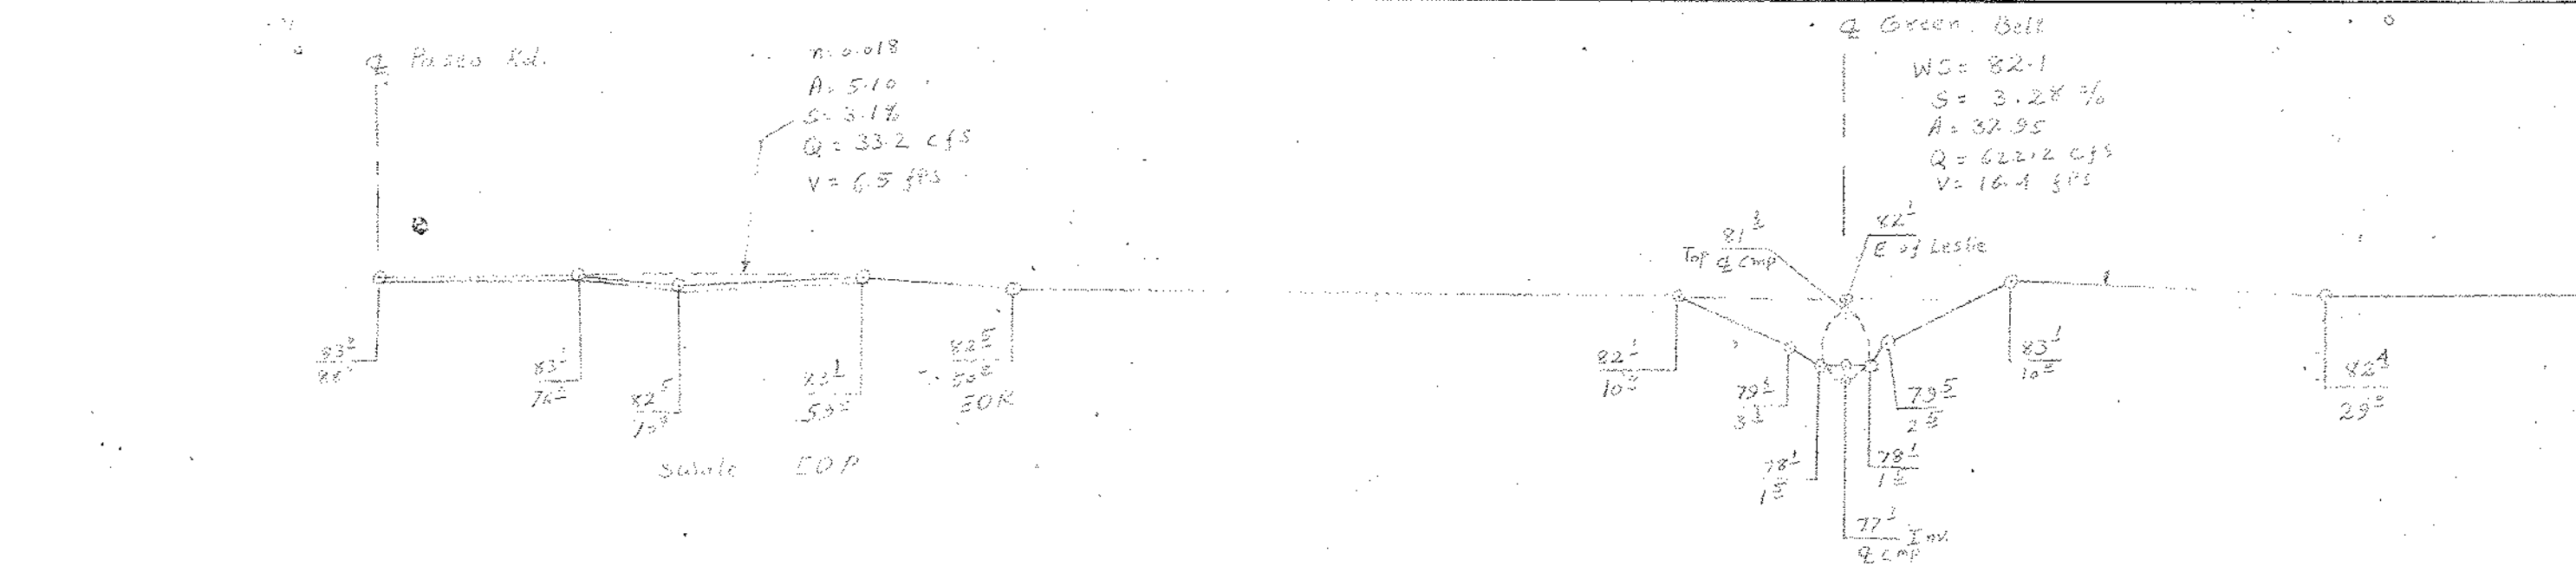

Scale: 1"=10'

JOB NO. 73-1067				VAN BUREN PHASE 7			
FROM:				CROSS SECTIONS			
TO:							
SCALE: Vert. AS SHOWN		APPROVED BY: (Signature)		PLAN BY: O.E.W. N.H.P.		DRAWN BY: N.H.P.	
SURVEYED BY: (Signature)		CHECKED BY: (Signature)		UNITED WESTERN ENGINEERS		PLATE 5	
				4525 Northpark Drive		Colorado Springs, Colorado	